




| QUADRO DE VOLUMES ATERRO | |
|---------------------------------|--|
| VOLUME 1 | $((20,93 \times 2,22)/2) \times 8,32 = 193,29$ |
| VOLUME 2 | $((8,22 \times 2,05)/2) \times 8,32 = 70,10$ |
| TOTAL | 263,39m ³ |
| QUADRO DE ÁREA DE REGULARIZAÇÃO | |
| ÁREA 1 | $(13,22 - 8,22) \times 8,32 = 41,60$ |
| TOTAL | 41,60m ² |

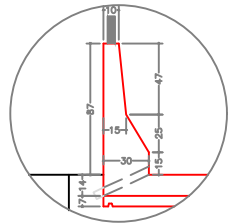


2 GUARDA-RODAS
ESCALA: 1:25

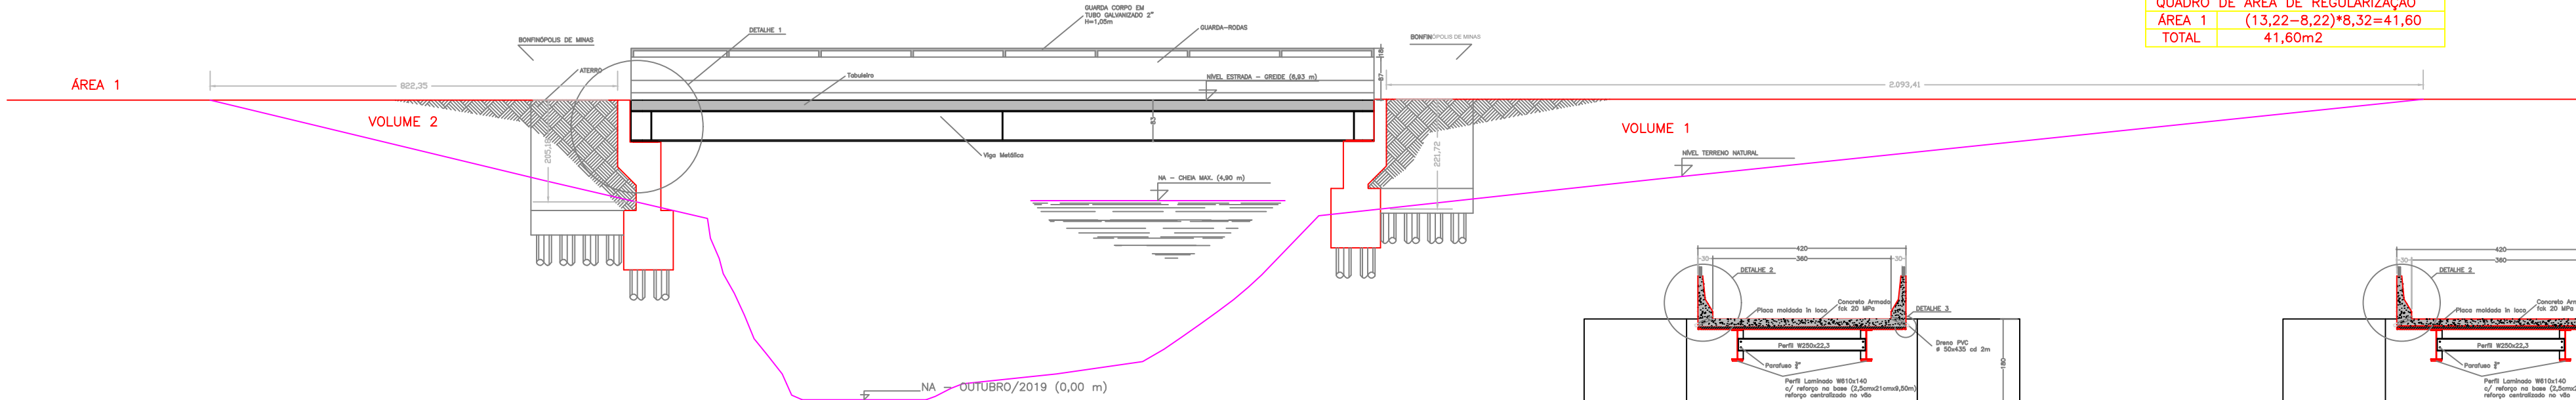


CORTE AA
ESCALA: 1:50

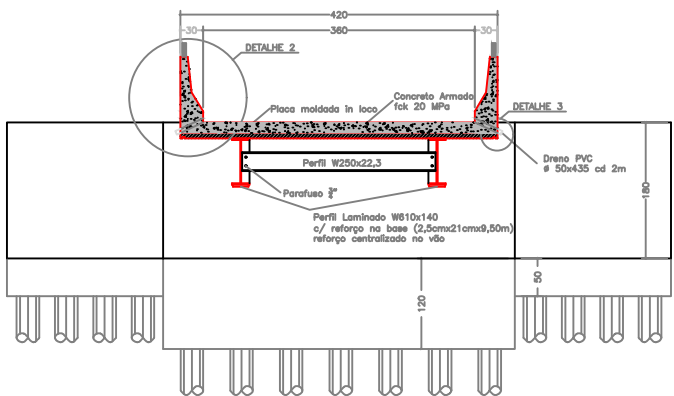


CORTE BB
ESCALA: 1:50

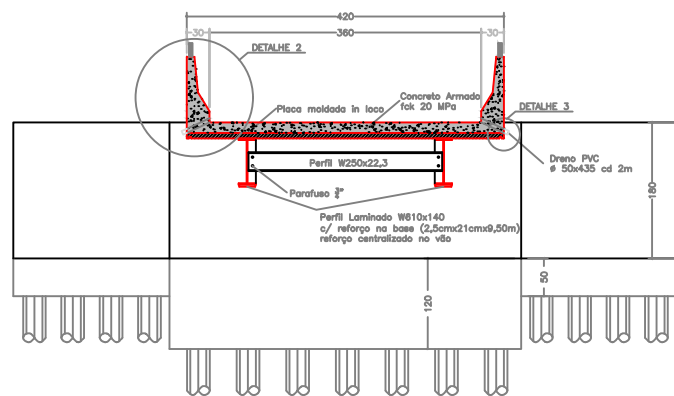


CORTE CC
ESCALA: 1:50

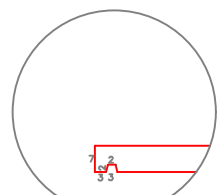


3 PINGADEIRA
ESCALA: 1:10

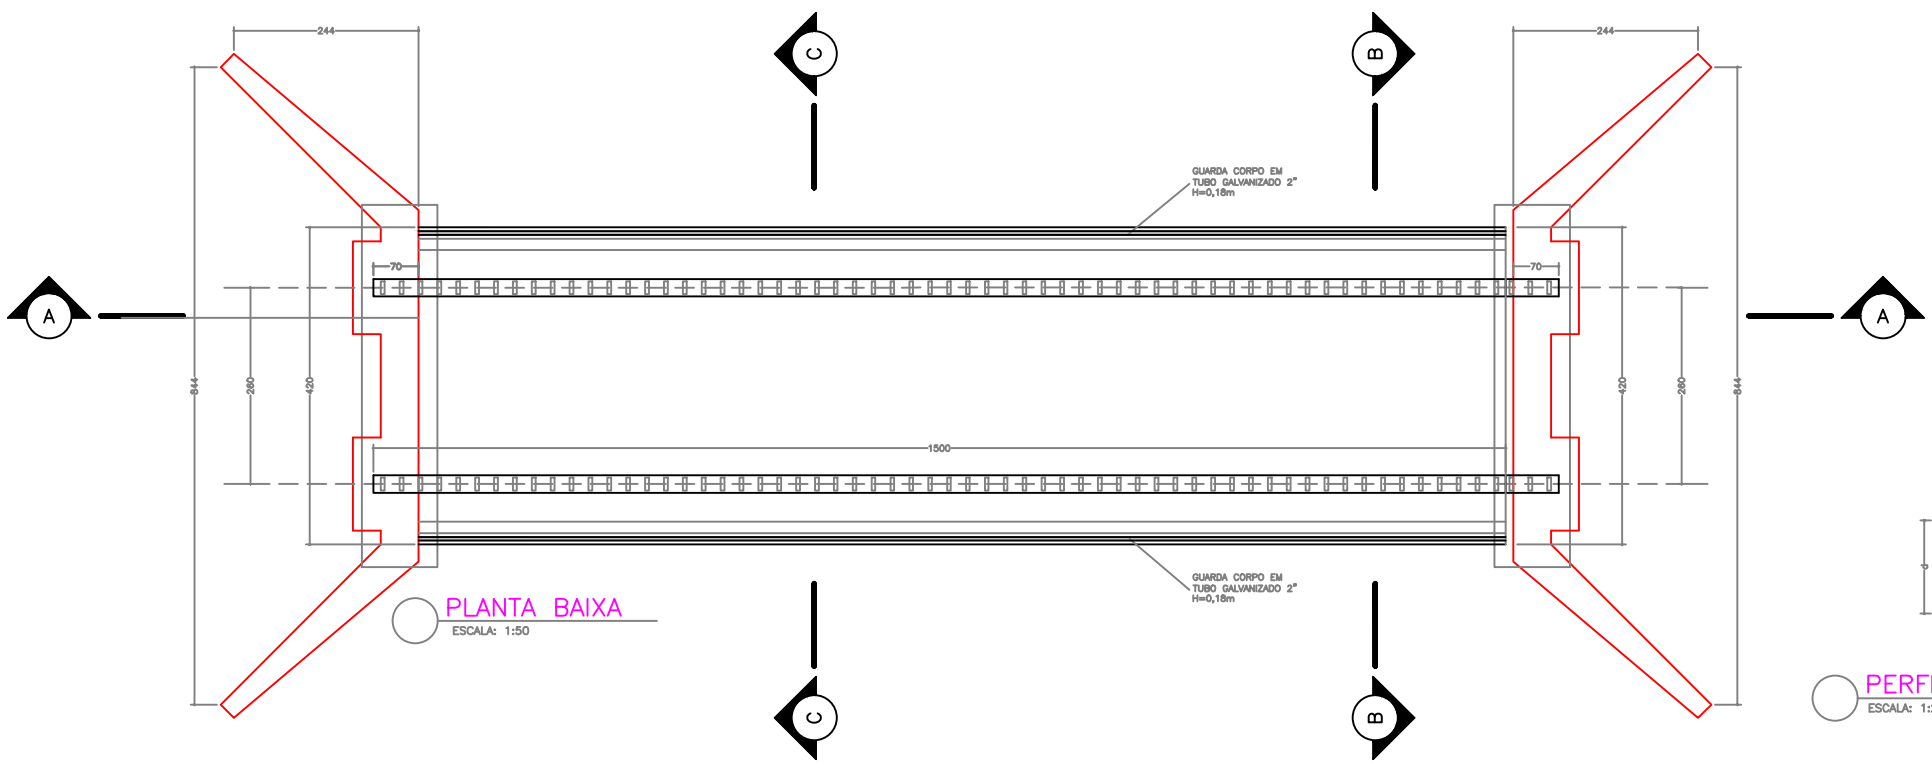


PLANTA BAIXA
ESCALA: 1:50

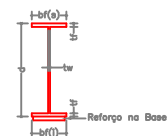


PERFIS LAMINADOS 2 x W610x140 x 15 metros
ESCALA: 1:25

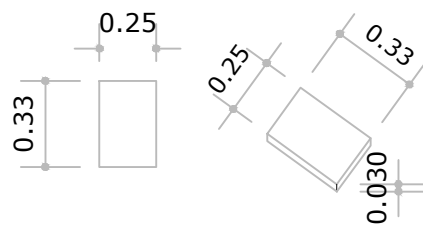


DETALHE NEOPRENE
SEM ESCALA

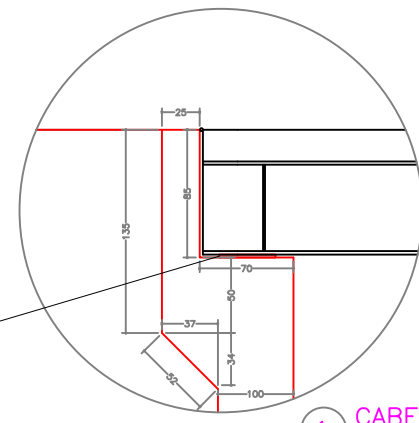


1 CABECEIRA
ESCALA: 1:25

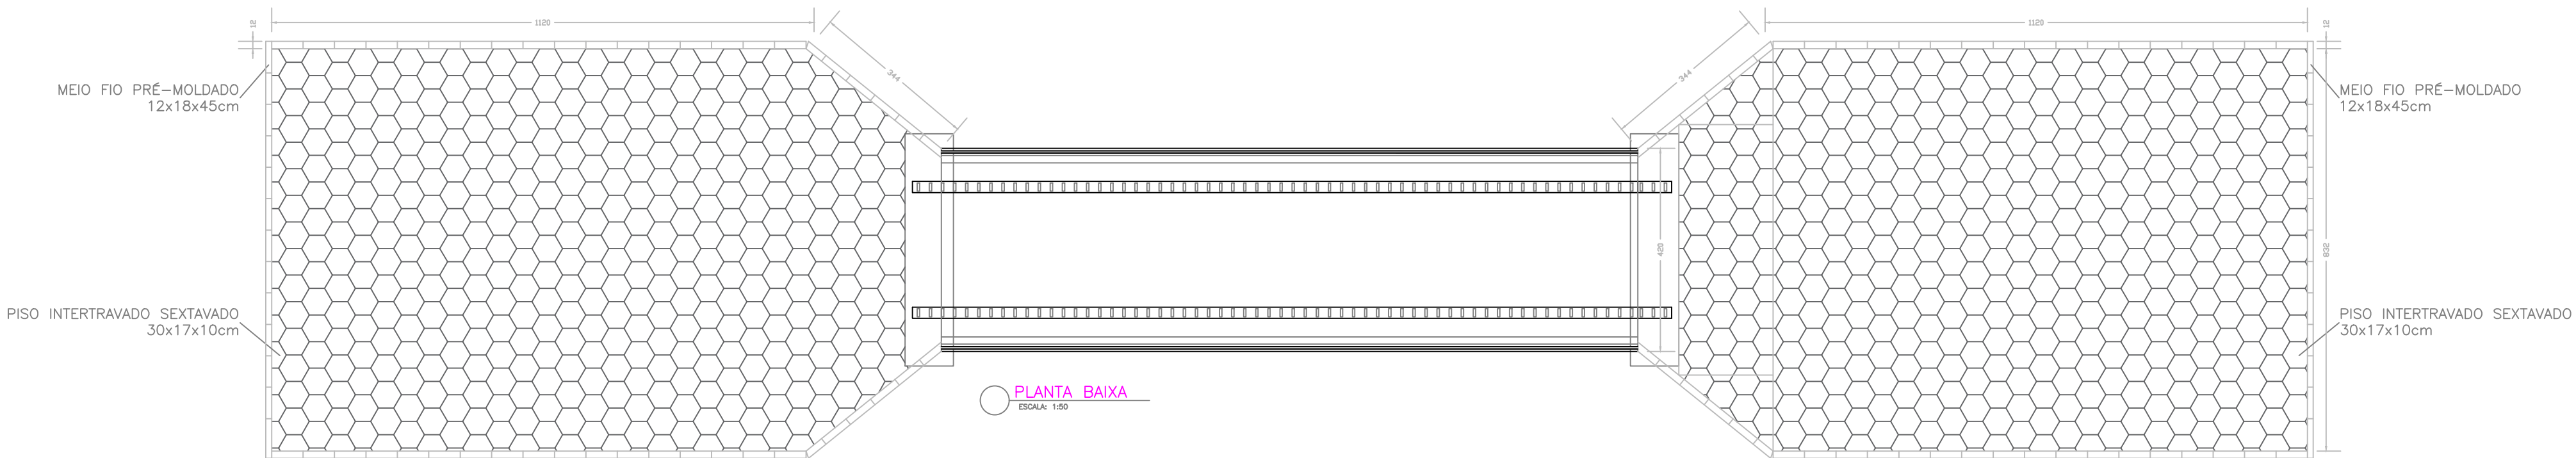


PLANTA BAIXA
ESCALA: 1:50

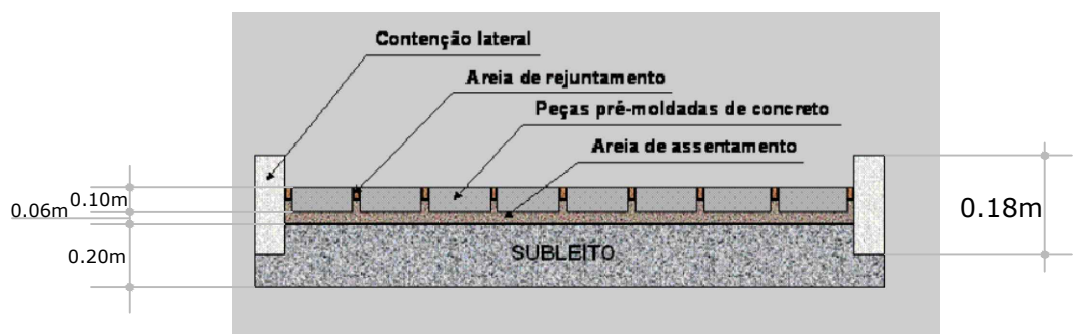

DETALHE DE ASSENTAMENTO DOS PISOS
SEM ESCALA

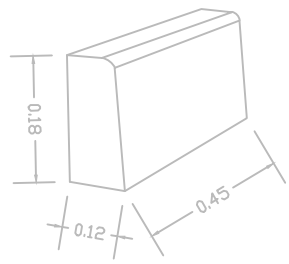

DETALHE DO MEIO FIO
SEM ESCALA

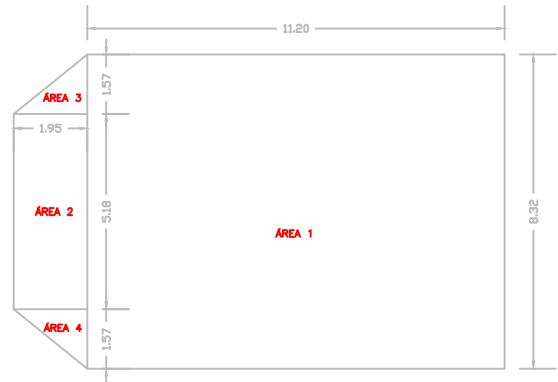

| QUADRO DE ÁREAS CALÇAMENTO | |
|----------------------------|-------------------------------|
| ÁREA 1 | $8,32 \times 11,20 = 93,18$ |
| ÁREA 2 | $1,95 \times 5,18 = 10,10$ |
| ÁREA 3 | $(1,57 \times 1,95)/2 = 1,53$ |
| ÁREA 4 | $(1,57 \times 1,95)/2 = 1,53$ |
| TOTAL | 106,34m ² |